

City of Fitchburg Planning/Zoning Department 5520 Lacy Road Fitchburg, Wi 53711 (608-270-4200)

SMARTCODE BUILDING/SITE PLAN APPLICATION (ARTICLE 5)

Location of Property: Street Address: Lot 5 - Southwest corner of Lacy Road and Syene Road			
Legal Description - (Metes & Bounds, or Lot No. And Plat): Lot 5, North Park Fitchburg, as recorded in Volume 60-030A of Plats, on Pages 154-156, as Document Number 5087380, Page County Pages			
	of Plats, on Pages 154-156, as Document Number 5087380, Dane County Registry, located in the NE 1/4 of the NW 1/4 of Section 14, in Township 06 North, Range 09 East, in the City of Fitchburg, Dane County, Wisconsin, containing 40,719 square feet, more or less.		
2. Description of Project: 71-unit apartment bui			
3. Existing Transect Zone: T5 Article 3	or Article 4 approval date:		
	sity (if applicable): 550 sf/du		
5. Building/Site Plan applications shall provide plans and	d information showing the following:		
 Building Disposition Building Configuration Building Use Parking calculation & location Number of dwelling units Base Residential Density Building square footage All requests for Administrative Waivers, if any All requests for Administrative Approvals, if any All known requests for Conditional Use Permits, if any Civic Building design(s) 	 12. Landscape Standards 13. Signage Standards 14. Special Requirements, if any 15. Architectural Standards 16. Fencing Standards 17. Lighting Standards 18. Statistics, maps and other documentation showing how the Article 5 application, in combination with the past approved Article 5 plans, will meet the approved Community Regulating Plan, and the standards of this Chapter. 		
***Also submit all mapping in either CADD or GIS files			
Current Owner(s) of Property: Goldleaf Fitchburg	LLC		
Address: 2379 University Ave.	Phone No.: 608-233-4423		
Contact Person: Mike Filkouski	mfilkouski@littlecreekconst.com		
Address: 7266 Cty Hwy V V, Sun Prairie, WI 53	590 Phone No.: 608-628-1116		
Respectfully Submitted By: Muchael Agent's Signature *(If multiple owners, application shall include statement of consent by all property owners)			
PLEASE NOTE – Applicants shall be responsible for legal of City. It is the responsibility of the owner/applicant to intrequirements.	7.4.2		
*Application shall be accompanied by one (1) PDF document of plans, two (2) reduced sets of plans (11" \times 17"), and the requirements	of complete submittal, one (1) full-size set uired CADD or GIS files for mapping.		
FOR CITY USE ONLY			
Date Received: 102015 Permit Request No.:	APPROVED 2/24/15 2/24/2015 W/ affached conditions.		
	*		

Lot 5 North Park Article 5 Conditions:

- 1.) No other permit or approval is waived or deemed satisfied except for the approval provided herein.
- 2.) Approval is based on plan set with site plan dated February 5, 2015, accompanying materials and responses to staff comments, along with ADR & Administrative Approvals/Waivers granted by the Plan Commission on 2/17/2015.
- 3.) All signage shall follow the requirements of Chapter 23 and obtain proper approvals for all signage.

SITE PLAN REVIEW CHECKLIST:

YES	<u>NO</u>	
X		Signed and completed Building / Site Plan – Article 5 Application
X		Proposals / design compliant with Ch. 23 SmartCode District
X		Vicinity map (no larger than 11 x 17)
X		2 (two) reduced size (11 x 17) plan sets
X		1 (one) full set of bounded drawings, include landscape plans
X		1 (one) electronic copy (.tif or .pdf) of the plan set
X		CADD or GIS files for all mapping
		Plans to include existing and proposed information on the following:
<u>X</u>		Location of structures, improvements and landscaping
X		North arrow and scale bar
X		Site boundaries
X		Setback distance from property lines
X		Rights-of-way, property lines and easements
<u>X</u>		Location & dimensions of driveways, streets and sidewalks
X		On-site parking and circulation
n/a	7112	Location of loading spaces, if applicable
<u>X</u>		Location of trash receptacle enclosure
<u>X</u>		Location of all outdoor electrical, plumbing and mechanical equipment
X		Landscaping Plan for site
TBD		Signage Plan for site (type & fixtures)
X		Elevations for each side of the building detailing the materials & colors
<u>X</u>		Fencing Plan (if installing fence)
X		Lighting Plan (in footcandles) & fixtures cut-sheets
X		Site plan data table containing: transect zone, site size in square feet or acres, lot coverage by building in square feet and percentage, residential density in units per acre (if applicable), square feet of impervious surface and parking and landscaping calculations.

ARTICLE 5 SUPPLEMENTAL FORM: Revised 1/30/15

Building Disposition:			
Lot(s) 5 Plat North Park			
Transect Zone: T5			
Lot Width 214'-0" Lot Coverage 76%			
Type of Building: Edgeyard Sideyard Rearyard Courtyard Specialized			
Principal Building Setbacks: Front (principal) 12' Front (secondary) 12' Side 10' Rear 31'-6"			
Primary Setback: 12' feet Frontage buildout (if applicable): 89.4 %			
Outbuilding: Yes No			
Outbuilding Setbacks: Front n/a Side n/a Rear n/a			
Building Configuration:			
Type of Private Frontage: ☐ Common Yard ☐ Porch & Fence ☐ Light court ☐ Forecourt			
■ Stoop			
☐ Parking Lot ☐ Common Entry & Planter			
% of clear glass of 1 st story Façade: <u>37.1</u> %			
Overall building height: 46' feet stories			
1 st story: feet			
2 nd story: 10'-8" feet			
3 [X] story: feet			
4th story: 10'-8" Building Use:			
Use of principal building: Multi-family residential			
71			
# of residential dwelling units in principal building (if applicable): dwelling units Use of accessory building: n/a			
*If multiple uses in building, please provide square footage of each type of use.			
Parking & Density:			
# of parking stalls provided within the Lot: 27 site/60 garage			
# of parking stalls along parking lane corresponding to the Lot Frontage:			
# of parking stalls by lease or purchase from a Civic Parking Reserve within the Community Unit: ${\color{blue}0}$			
If looking to use Effective Parking standards, applicant shall provide completed Parking Occupancy Rate Table (Table 20)			
Current density for transect zone within the block: 76 units/acre (per 5.9.2f)			

Parking Location:
Drive width: 20'-24'
Material of parking / drive areas: Asphalt
<u>Landscape:</u>
% of landscape area of 1 st Layer of Principal Frontage: <u>52</u> % (minimum 30%)
% of landscape area of 1 st Layer of Secondary Frontage: <u>56</u> % (minimum 30%)
of trees planted within the 1 st Layer: 4
Requirements: T3 – 1 tree shall be planted within the 1 st Layer for every 800 sq. ft of landscape area
T4 – minimum of 1 Understory Tree or 6 shrubs planted within 1 st Layer for every 500 sq. ft. of 1 st Layer landscape area.
T5 – Trees not required in 1 st Layer.
Signage:
A or B grid street:
Type of sign:(* note: A sign permit is required for all signs)
Architectural: For buildings other than single-family and two-family Edgeyard & Sideyard Residential: Type of building materials: brick veneer, vinyl siding, composite panels, aluminum railings, precast sills/bands *Vinyl siding is not permitted.
Fence: ■ Yes □ No
If yes, fence at the 1 st Layer shall be painted or stained.
Balcony or porch: ■ Yes □ No
Fencing:
Height of fence (if applicable): 3'-6" feet
<u>Lighting:</u> Are all parking lot and exterior building lighting on private lots dark sky approved or full cut-off fixtures? ■ Yes □ No
Average lighting levels, in footcandles, at the building frontage line: $\underline{0}$



City of Fitchburg Planning/Zoning Department 5520 Lacy Road Fitchburg, WI 53711 (608-270-4200)

ADMINISTRATIVE WAIVER **APPLICATION**

Location of Property:

Street Address: Lot 5 - Southwest corner of Lacy Road and Syene Road

Legal Description - (Metes & Bounds, or Lot No. And Plat): Lot 5, North Park Fitchburg, as recorded in Volume 60-030A

of Plats. on Pages 154-156, as Document Number 5087380. Dane County Registry. located in the NE 1/4 of the NW 1/4 of Section 14, in Township 06 North, Range 09 East, in the City of Fitchburg, Dane County, Wisconsin, containing 40,719 square feet, more or less.

Administrative Waiver Det	taile.
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Administrative Waiver Application shall be submitted concurrent with a SmartCode Rezoning 1. Application, a Regulating Plan Application or Site/Building Plan Application.

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Aumm	Strative	Walver	Checklist:

2. be consi	All documentation, including maps, text, drawings idered in support of their Waiver(s) should be subm	and statistical data that the applicant wishes to itted with this application.			
Administrative	e Waiver Checklist:				
	Describe each specific Waiver requested, include 23 SmartCode District, clearly noting what was the difference.	ding citation of the provision from Chapter required by the Code, what is proposed and			
	the difference. 2. Describe why each Waiver is requested. Why can the current regulations not be met? 3. Describe any mitigation strategies to offset the effect of the relief requested.				
The preceding Zoning Admini	information is considered to be the minimum is information for restrator may require additional information for re	information for submission, and the eview.			
Current Owner	(s) of Property: Goldleaf Fitchburg LLC				
Address: 2379	9 University Ave.	Phone No.: 608-233-4423			
Contact Person	n: Mike Filkouski	E-mail: mfilkouski@littlecreekconst.c			
Address: 7266	6 Cty Hwy V V, Sun Prairie, WI 53590	Phone No.: 608-628-1116			
Respectfully Submitted By: Muchael Jacobs Date: 1/14/2015					
	"(If multiple owners, application shall include staten	nent of consent by all property owners)			
PLEASE NOTE – Applicants shall be responsible for legal or outside consultant costs incurred by the City. It is the responsibility of the owner/applicant to insure compliance with all local and state requirements.					

FOR CITY USE ONLY	
Date Received: 262015	
Comments:	
APPROVED by Plan Commission	
as part of 2/17/2015 ADR approval.	

January 28, 2015

Mr. Tom Hovel
City Planner
Department of Planning and Development
City of Fitchburg
5520 Lacy Road
Fitchburg WI 53711

Re: Administrative Waiver Lacy Rd. and Syene Rd. – Lot 5

KBA Project # 1332

Dear Mr. Hovel,

This is a request for an Administrative Waiver to allow a 71-unit apartment building to be classified as an edge yard building in the development located at the southwest corner of Lacy Road and Syene Road. Due to the corner lot configuration of the site it is impossible to designate this building as a rear yard building as there is a 2 - 12 foot setback required on the secondary frontage side of the building.

Thank you for your time reviewing our proposal.

Sincerely,

J. Randy Bruce Managing Member





City of Fitchburg Planning/Zoning Department 5520 Lacy Road Fitchburg, WI 53711 (608-270-4200)

SMARTCODE ADMINISTRATIVE WAIVER **APPLICATION**

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- 2. All documentation, including maps, text, drawings and statistical data that the applicant wishes to be considered in support of their Waiver(s) should be submitted with this application.

Adm	inistra	ative	Waiver	Chac	Idiat.
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Administrative Waiver Checklist:			
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The preceding information is considered to be the minimum information for submission, and the Zoning Administrator may require additional information for review.			
Current Owner(s) of Property: Goldleaf Fitchburg LLC			
Address: 2379 University Ave. Phone No.: 608-233-4423			
Contact Perso	n: Mike Filkouski	E-mail: mfilkouski@littlecreekconst.c	
Address: 726	66 Cty Hwy V V, Sun Prairie, WI 53590	Phone No.: 608-628-1116	
Respectfully Submitted By: Michael JE Liby Date: 1/1/2015 Owner's or Authorized Agent's Signature *(If multiple owners, application shall include statement of consent by all property owners)			
PLEASE NOTE - Applicants shall be responsible for legal or outside consultant costs incurred by the			

PL City. It is the responsibility of the owner/applicant to insure compliance with all local and state

FOR CITY USE ONLY	
Date Received: 2/5/2015	
Comments:	
APPROVED by Plan Commission as part of 2/17/2015	
ADR approval.	

January 12, 2015

Mr. Tom Hovel
City Planner
Department of Planning and Development
City of Fitchburg
5520 Lacy Road
Fitchburg WI 53711

Re: Administrative Waiver Lacy Rd. and Syene Rd. – Lot 5

KBA Project # 1332

Dear Mr. Hovel,

This is a request for an Administrative Waiver to allow up to a 44" recess behind the primary setback line on a 71-unit apartment building in the development located at the southwest corner of Lacy Road and Syene Road.

Ordinance No. 2014-O-20, which created Article 5.6.2 f vii, states that the Plan Commission may grant Administrative Approval for a maximum 44" recess behind the primary setback of a multifamily unit. The other conditions of this Article have been met with the current plans. The additional recesses are needed to allow for the placement of HVAC grills on the side wall of the recessed balconies.

Aurora Ave elevation: 146'-10'' total length -39'-0'' recesses greater than 18'' = 107'-10'' (73.4%) Syene Rd elevation: 191'-10'' total length -52'-2'' recesses greater than 18'' = 139'-8'' (72.8%)

Thank you for your time reviewing our proposal.

Sincerely,

J. Randy Bruce Managing Member





City of Fitchburg Planning/Zoning Department 5520 Lacy Road Fitchburg, WI 53711 (608-270-4200)

SMARTCODE ADMINISTRATIVE WAIVER APPLICATION

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- 2. All documentation, including maps, text, drawings and statistical data that the applicant wishes to be considered in support of their Waiver(s) should be submitted with this application.

Admini	istrative	Waiver	Chack	liet.
* ********	SHALIVE	AAGIAGI	CHECK	1151.

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Address: 7266	6 Cty Hwy V V, Sun Prairie, WI 53590	Phone No.: 608-628-1116
Respectfully S	Owner's or Authorized Agent's Signal	Date: 1/1/2015
	*(If multiple owners, application shall include staten	nent of consent by all property owners)

PLEASE NOTE - Applicants shall be responsible for legal or outside consultant costs incurred by the City. It is the responsibility of the owner/applicant to insure compliance with all local and state requirements.

FOR CITY USE ONLY	
Date Received: 2/5/2013	
Comments:	
APPROVED by Plan Commission	
as part of 2/17/2015	
ADR approval.	

January 12, 2015

Mr. Tom Hovel
City Planner
Department of Planning and Development
City of Fitchburg
5520 Lacy Road
Fitchburg WI 53711

Re: Administrative Waiver Lacy Rd. and 5yene Rd. – Lot 5

KBA Project # 1332

Dear Mr. Hovel,

This is a request for an Administrative Waiver to allow the use of vinyl siding on the façade of a 71-unit apartment building in the development located at the southwest corner of Lacy Road and Syene Road.

Ordinance No. 2014-O-13, which amends Article 5.13.4c and 5.13.5b relative to vinyl siding states that the Plan Commission may grant Administrative Approval for the use of vinyl siding. The characteristics of vinyl siding, including its durability and low maintenance requirements, will ensure that this building will maintain its appearance well into the future. The other conditions of this Ordinance have been met with the current plans.

Thank you for your time reviewing our proposal.

Sincerely,

J. Randy Bruce Managing Member





City of Fitchburg Planning/Zoning Department 5520 Lacy Road Fitchburg, WI 53711 (608-270-4200)

SMARTCODE ADMINISTRATIVE WAIVER APPLICATION

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The pr	receding g Admin	in: istr	formation is considered to be the minimum i ator may require additional information for re	nformation for submission, and the view.
Currer	nt Owner	(s)	of Property: Goldleaf Fitchburg LLC	
Addre	ss: <u>237</u> 9	9 U	niversity Ave.	Phone No.: 608-233-4423
Contac	ct Perso	n:	Mike Filkouski	E-mail: mfilkouski@littlecreekconst.c
Addres	ss: <u>726</u> 6	6 C	ty Hwy V V, Sun Prairie, WI 53590	Phone No.: 608-628-1116
Respe	ctfully S	ubr	mitted By: Michael JEllans	Date: 1/14/2015
		*(lf	Owner's or Authorized Agent's Signat multiple owners, application shall include statem	ure ent of consent by all property owners)
PLEAS City. require		_	Applicants shall be responsible for legal or out esponsibility of the owner/applicant to insure	oido serre III I I I I I
FOR C	TY USE	ON	ILY	
Date R	eceived:	2	5/2015	

Comments:

by Plan Commission as para of 2/17/2015

ADR approval.

January 12, 2015

Mr. Tom Hovel
City Planner
Department of Planning and Development
City of Fitchburg
5520 Lacy Road
Fitchburg WI 53711

Re: Administrative Waiver Lacy Rd. and Syene Rd. – Lot 5

KBA Project # 1332

Dear Mr. Hovel,

This is a request for an Administrative Waiver to allow the use of a hedge streetscreen for the non-parking areas on a 71-unit apartment building in the development located at the southwest corner of Lacy Road and Syene Road. The owner would like to pursue Section 5.7.5 (f) with the intent of adding interest with plantings instead of standard fencing materials.

Street screening at parking areas will remain per Smartcode requirements as shown on the submitted drawings.

Thank you for your time reviewing our proposal.


Sincerely,


J. Randy Bruce Managing Member







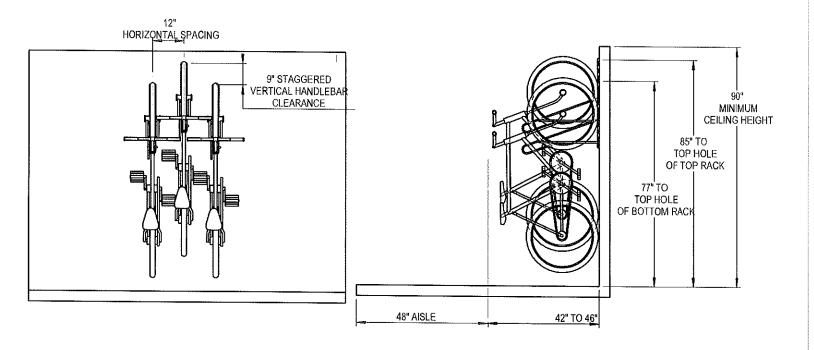

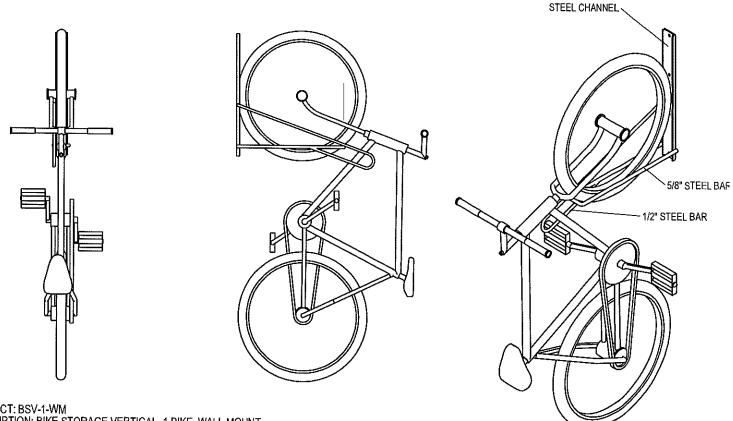

PRODUCT: BSV-1-WM DESCRIPTION: BIKE STORAGE VERTICAL, 1 BIKE, WALL MOUNT

DATE: 8-7-09 ENG: BLW


CONFIDENTIAL DRAWING AND INFORMATION IS NOT TO BE COPIED OR DISCLOSED TO OTHERS WITHOUT THE CONSENT OF TRILARY, INC. SPECIFICATIONS ARE SUBJECT TO CHANGE WITHOUT NOTICE.


02007 TRILARY, INC. ALL PROPRIETARY RIGHTS RESERVED.

NOTES:


- INSTALL BIKE RACKS ACCORDING TO MANUFACTURER'S SPECIFICATIONS.
 CONSULTANT TO SELECT COLOR(FINISH), SEE MANUFACTURER'S SPECIFICATION
 SEE SITE PLAN FOR LOCATION OR CONSULT OWNER.




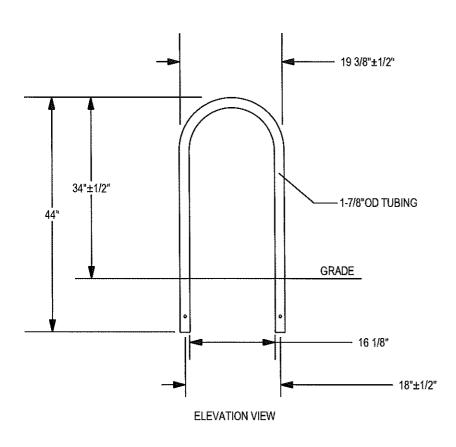


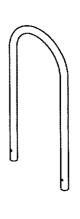


CHECK DESIRED MOUNT II

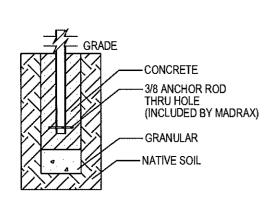

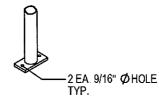

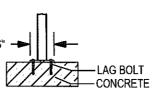

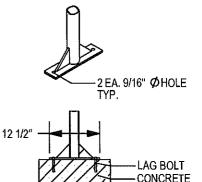

☐ IN GROUND MOUNT (IG)

☐ SURFACE FLANGE MOUNT (SF) SECTION VIEWS

☐ SURFACE GUSSET MOUNT (SG) **UPCHARGE**

PRODUCT: U190-IG(SF,SG) DESCRIPTION: 'U' BIKE RACK

2 BIKE, SURFACE OR IN GROUND MOUNT

DATE: 8-5-02 ENG: TLG

CONFIDENTIAL DRAWING AND INFORMATION IS NOT TO BE COPIED OR DISCLOSED TO OTHERS WITHOUT THE CONSENT OF TRILARY, INC. SPECIFICATIONS ARE SUBJECT TO CHANGE WITHOUT NOTICE.

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NOTES

- INSTALL BIKE RACKS ACCORDING TO MANUFACTURER'S SPECIFICATIONS.
 CONSULTANT TO SELECT COLOR(FINISH), SEE MANUFACTURER'S SPECIFICATIONS.
 SEE SITE PLAN FOR LOCATION OR CONSULT OWNER.

Specification Sheet



Monogram 46

Vinyl Siding

General Description: MonogramTM provides the look of wood siding, but does not require the upkeep common to wood. Monogram siding is manufactured with TrueTextureTM rough cedar finish molded directly from real cedar boards. Available in a selection of profiles, Monogram offers the industry's widest selection of colors. It is appropriate for use in new construction for single family homes, multi-housing projects and light commercial developments. Monogram is also an ideal product for remodeling.

Styles:

Profile	Finish	Panel Projection (Nominal)	Wall Thickness (Nominal)	Lock Design	Colors	Accessory Pocket
Double 4" Clapboard	Rough Cedar	3/4"	.046"	CertiLock™ post-formed positive lock	41	3/4"
Double 5" Clapboard	Rough Cedar	3/4"	.046"	CertiLock TM post-formed positive lock	19	3/4**
Double 5" Dutchlap	Rough Cedar	3/4"	.046"	CertiLock TM post-formed positive lock	27	3/4"

Colors: Monogram siding profiles are available in the industry's widest selection of colors. All colors are Spectrophotometer controlled and utilize exclusive PermaColorTM color science.

Arbor Blend**	Cypress	Heritage Cream	Pacific Blue*	Sterling Gray
Arctic Blend**	Desert Tan	Herringbone	Sable Brown*	Suede
Autumn Red*	Flagstone*	Ivy Green*	Sandpiper	Terra Cotta*
Autumn Yellow	Forest*	Light Maple	Sandstone Beige	Timber Blend**
Bermuda Blue	Frontier Blend**	Linen	Savannah Wicker	Weathered Blend**
Buckskin	Glacier Blend*	Meadow Blend*	Seagrass	
Canyon Blend*	Granite Gray	Mountain Cedar*	Silver Ash	
Charcoal Gray*	Green Tea	Natural Clay	Snow	
Colonial White	Hearthstone*	Oxford Blue	Spruce*	

^{*} Deluxe Color: Deluxe colors utilize CertainTeed's proprietary manufacturing process to provide the unique appearance of semi-transparent and solid stained wood siding.

STUDfinderTM: The patented STUDfinder Installation System combines precisely engineered nail slot locations with graphics. Nail slots are positioned 16" on center to allow for alignment with studs. STUDfinder graphics centered at each slot provide a quick and easy guide to help locate studs.

RigidFormTM: Monogram RigidForm 220 technology has a stiff, double-thick .092" nail hem for a straighter-on-the-wall appearance and wind load performance.

Lock: Uniquely designed for ease of installation, Monogram features the CertiLock™ locking system; a post-formed positive lock which provides for self-aligning installation. Properly installed panels will snap together with an audible "click" signaling that they are ready for nailing.

Accessories: CertainTeed manufactures a wide range of siding accessories which are compatible with Monogram siding styles and colors. Accessory products include installation components, soffit, window and door trim, corner lineals, corner systems and decorative moldings.

^{**} Premium Color: Made with an exclusive, highly durable polymer capstock combined with unique heat distortion modifiers that helps ensure long-term weatherability in darker hues that would otherwise quickly fail.

Composition: Monogram siding products are produced using CertaVin™ custom-formulated PVC resin. This resin is produced exclusively by CertainTeed, allowing CertainTeed to maintain the high quality of its siding products.

Technical Data: Monogram siding is in compliance with ASTM specification for Rigid Polyvinyl Chloride (PVC) Siding Insulated Vinyl Siding D 3679, and the requirements of section R703.11 of the International Residential Code, and section 1405.14 and 2603 of the International Building Code. Monogram siding meets or exceeds the properties noted in Table 1.

ASTM E 84	Mcets Class 1 flame spread requirements as tested according to ASTM E84.
ASTM D 1929	Sclf-ignition temperature 813°F
ASTM D 635	Material is self-extinguishing with no measurable extent of burn when tested in accordance with this specification.
NFPA 268	Radiant Heat Test - Ignition Resistance of Exterior Walls - Conclusion that CertainTeed met the conditions for
	allowable use as specified in section 1406 of the International Building Code.

Important Fire Safety Information: When rigid vinyl siding is exposed to significant heat or flame, the vinyl will soften, sag, melt or burn, and may thereby expose material underneath. Care must be exercised when selecting underlayment materials because many underlayment materials are made from organic materials that are combustible. You should ascertain the fire properties of underlayment materials prior to installation. All materials should be installed in accordance with local, state and federal Building Code and fire regulations.

Wind Load Testing: CertainTeed Monogram double 4" siding has been tested per ASTM D 5206 standard test method for resistance to negative wind load pressures of 63 psf, which equates to more than 220 mph per VSI windspeed calculation guidelines, when installed with nails positioned 16" on center. Check with your local building inspector for wind load requirements in your area on the type of structure you are building.

Documents: CertainTeed Vinyl Siding meets the requirements of one or more of the following specifications.

Texas Department of Insurance Product Evaluation EC-11

Conforms to ASTM Specification D3679

Florida BCIS Approval FL1573

ICC-ES Evaluation Report ESR-1066

CCMC #13008-L

For specific product evaluation/approval information, call 800-233-8990.

Installation: Prior to commencing work, verify governing dimensions of building, examine, clean and repair, if necessary, any adjoining work on which the siding is in any way dependent for its proper installation. Sheathing materials must have an acceptable working surface. Siding, soffit and accessories shall be installed in accordance with the latest editions of CertainTeed installation manuals on siding and soffit. Installation manuals are available from CertainTeed and its distributors.

Warranty: CertainTeed supports Monogram siding products with a Lifetime Limited Warranty including PermaColor Lifetime Fade Protection to the original homeowner. The warranty is transferable if the home is sold.


Technical Services: CertainTeed maintains an Architectural Services staff to assist building professionals with questions regarding CertainTeed siding products. Call 800-233-8990 for samples and answers to technical or installation questions.


Sample Short Form Specification: Siding as shown on drawings or specified herein shall be Monogram Vinyl Siding as manufactured by CertainTced Corporation, Valley Forge, PA. The siding shall have a .092" thick nail hem. Installation shall be in accordance with manufacturer's instructions.

Three-part Format Specifications: Long form specifications in three-part format are available from CertainTeed by calling our Architectural Services Staff at 800-233-8990. These specifications are also available on our website at <u>certainteed.com</u>.



CertainTeed Corporation P.O. Box 860 Valley Forge, PA 19482 certainteed.com © 12/13

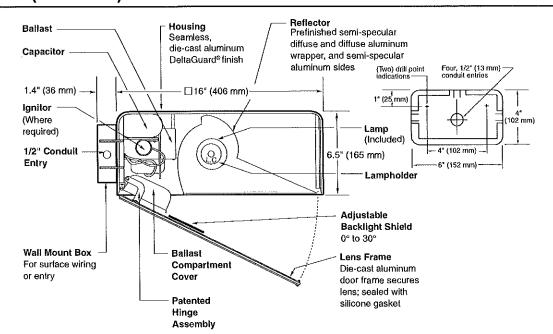

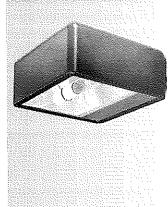

Notes

SPEC#	WATTAGE	CATALOG #
F	PULSE START META	AL HALIDE
SPEC#	150W PSMH	ACW615-(a)(b)
SPEC#	200W PSMH	ACW620-(a)(b)
SPEC#	250W PSMH	ACW625-(a)(b)
SPEC#	320W PSMH	ACW632-(a)(b)
SPEC# •	350W PSMH	ACW635-(a)(b)
SPEC# 0	400W PSMH	ACW640-(a)(b)
***************************************	HIGH PRESSURE S	ODIUM
SPEC#	250W HPS	ACW525-(a)(b)
SPEC#	400W HPS	ACW540-(a)(b)

Specify (a) Voltage & (b) Options. P Reduced envelope ED28 lamp.

120/208/240/277V (Standard)
120,200,210,2111 (Statituala)
120/277/347V (Canada Only) (Standard)
120V
277V
277V Reactor (PSMH Only)
208V
240V
480V
347V (Canada Only)

contact your Ruud Lighting authorized International Distributor.

	(b) OPTIONS (factory-installed)
-(a)F	Fusing
-(a)P	Button Photocell
-5P	External Photocell (for 480V)
Q	Quartz Standby (includes 100W quartz lamp) (N/A on 277V Reacfor)

Specify (a) Single Voltage - See Voltage Suffix Key

GENERAL DESCRIPTION

60° forward throw sharp cutoff luminaire with adjustable backlight control for HID lamp, totally enclosed. Backlight shield provides precise cutoff adjustability from 0° (nadir) to 30° (house-side). Housing is seamless, die-cast aluminum. Fixture mounts to wall with a 4" (102 mm) x 6" (152 mm) x 1.4" (36 mm) cast aluminum mounting box and gasket. Two 5/16" threaded mounting studs are supplied with nuts and sealing washers to attach fixture to mounting box. Also provided are four threaded and closed 1/2" conduit entries. Lens assembly consists of rigid aluminum frame and high-impact, clear-tempered glass, and backlight shield.

ELECTRICAL

Fixture includes clear, mogul-base lamp; 320 - 400W PSMH utilize the ED28 reduced envelope lamp. Pulse-rated porcelain enclosed. 4kv-rated screw-shell-type lampholder with spring-loaded center contact and lamp grips. 150° C temperature supply wire required. Lamp ignitor included. All ballast assemblies are high-power factor and use the following circuit type:

277V Reactor 150 - 400W PSMH

HX— High Reactance 150W PSMH

CWA — Constant Wattage Autotransformer 200 - 400W PSMH; 250 - 400W HPS

PATENTS

US 4.689.729: 4.709.312

LABELS

ANSI lamp wattage label supplied, visible during relamping. UL Listed in US and Canada for wet locations and enclosure classified IP65 per IEC 529 and IEC 598.

FINISH

Exclusive Colorfast DeltaGuard® finish features an E-coat epoxy primer with medium bronze ultra-durable powder topcoat, providing excellent resistance to corrosion, ultraviolet degradation and abrasion. The finish is covered by our seven-year limited warranty.

ACCESSORIES

FWG-16 Wire Guard


RUUD LIGHTING

16" (406 mm) AREA CUTOFF LIGHT


EPA RATING

Isofootcandle plots show initial footcandles at grade. (Footcandles \div 0.0929 = Lux)


EPA 0.93 for single fixture with 0° tilt (Consult factory for EPA rating on multiple units).

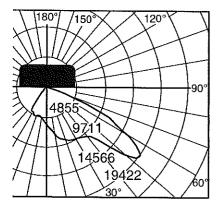


Candlepower distribution curve of 400W PSMH Area Cutott Light without backlight shield.

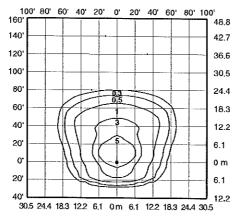


Isotootcandle plot of 400W PSMH Area Cutoff Light at 30' (9.1 m) mounting height, 0° vertical tilt, with backlight shield removed. (Plan view)

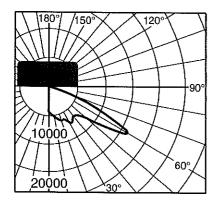

Lighting Sciences Inc. Certitied Test Report No. LSI 10246 Candlepower distribution curve of 250W HPS Area Cutoff Floodlight without backlight shield.

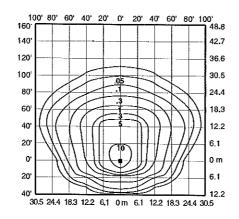


Isotootcandle plot of 400W HPS Area Cutoft Floodlight at 25' (7.6 m) mounting height, 0° vertical tilt, with backlight shield removed. (Plan view)

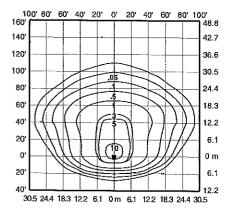

Isofootcandle plot of 400W HPS Area Cutott Floodlight at 25' (7.6 m) mounling height, O° vertical tilt, with backlight shield located for backlight cutott. (Plan view)



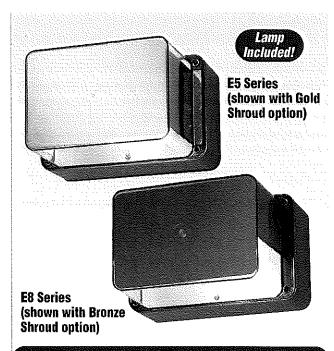


Up/Down Cutoff & Deep Shielded


E5 Series Up/Down Cutoff

The optics provide controlled uplight and downlight with side cutoff. The E5 Series optics are also available for vertical mounting; add suffix "R" to catalog number.

NOTE: 50-watt MH with sutfix "G" is supplied with a glass insert to allow operation in the wall-mounted position.

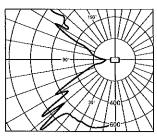


Candlepower Distribution Curve ot 50W HPS E5 Up/Down Cutoff Light.

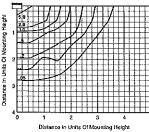


Isofootcandle plot of one 50W HPS E5 Up/Down Cutoff Light at 10' (3.0 m) mounting height (plan view).

E8 Series Deep Shielded


Front brightness shielding without sacrificing wide light distribution. The E8 works ideally over entrances.

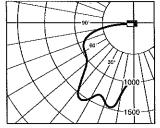

Candlepower Distribution Curve of 70W HPS E8 Deep Shielded Light.

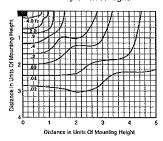

Isofootcandle plot of one 70W HPS E8 Deep Shielded Light at 15' (4.6 m) mounting height (plan view).

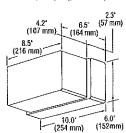

For 50, 70 and 100W HPS with quad-volt or tri-volt, and all MH fixtures, the housing depth is 3° (76 mm), and the overall tixture depth is 7.2° (183 mm).

	Wattage/	Catalog	Mounting	
Description	Lamp Type	Number	Position	
Up/Down Cutoff	50W MH	E5405-MG	Wall	*
,	35W HPS	E5503-1	Any	
	50W HPS	E5505-1	Any	
Deep Shielded	50W MH	E8405-M	Wall Down	ight only
	70W MH	E8407-M	Wall Down	ight only
	35W HPS	E8503-1	Any	
	50W HPS	E8505-1	Апу	
	70W HPS	E8507-1	Wall Down	ight only
	100W HPS	E8510-1	Wall Down	ight only
NDTE: Suffix "G" i	ndicates glass inse	rt is supplied.		
Options: (Factor	/-instalted)		Change	Add After
Description			Sutlix To	Sutlix
277V ballast (35–50	W HPS only)		2	
347V ballast (50W F	IPS only)		6	
Quad-volt ballast (7	0-100W HPS only)		M	
Tri-volt ballast (50 8	70W MH only)		Т	
Tri-volt ballast (70 8	100W HPS only)		T	
Photocell (120V, 277	·	V)	1, 2, 3, 4 or 6	
Bronze Color Shrou	*			BS
Gold Color Shroud	(not available on 100	W HPS)		6S
High Power Factor				H
Tamperproof Lens				j
Vertical Mounting (R
NDTE: Not availab	le when both hpt a	nd photocell su	pplied	
Polycarbonate Lens				V
Accessories: (Fi	eld-installed)			
Description		Ca	italog Numb	ier
Surtace Mounting			ESB-7	
Pole Mounting Bra			PAS-7	
Tamperproot Screv			TPS-1	
				Paç
				Page
Accessories				Page

Eo series Monuming	munupners
Height	Multiplier
7' (2.1 m)	2.04
8' (2.4 m)	1.56

7" (2.1 M)	2.04
8' (2.4 m)	1.56
9' (2.7 m)	1.23
10' (3,0 m)	1.00
12' (3.7 m)	0.69
15' (4.6 m)	0.44
20' (6.1 m)	0.25

The E5 Series photometric data was developed in testing Ruud fixtures with clear, 50W HPS 4,000 turnen medium base lamps. Footcandle readings for other wattages and lamp types may be obtained by multiplying the chart values by the following:

Lamp/Wallages	Multiplier
50W MH	0.85
35W HPS	0.56

E8 Series Mounting Multipliers

Height	Mulliplier
8' (2.4 m)	3.52
10° (3.0 m)	2.25
12' (3.7 m)	1.56
15' (4.6 m)	1.00
20' (6.1 m)	0.56
25' (7.6 m)	0.36

The E Series photometric data in this section was developed in testing Ruud tixtures with clear, 70W HPS 6,400 lumen medium base lamps. Footcandle readings for other wattages and lamp types may be obtained by multiplying the chart values by the tollowing:

the tenerality.	
Lamp/Wattages	Multiplier
50W MH	0.53
70W MH	0.86
35W HPS	0.35
50W HPS	0.63
100W HPS	1.48

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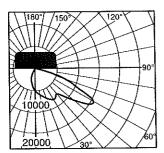
(800) 236-7000, 7 a.m. to 6 p.m. CT Fax: (800) 236-7500 • www.ruudlighting.com




This compact forward-throw retlector has a main beam of 60+ degrees from vertical (30 degrees from horizontal), providing wide lateral distribution and excellent uniformities. A Backlight Shield accessory (standard on Wall Mount) permits precise cutoff adjustability.

Three Sizes:

12" square x 5" deep (305 x 127 mm) 16" square x 6.5" deep (406 x 165 mm) 22" square x 9.3" deep (559 x 235 mm)



Candlepower distribution curve of 400W MH 16* Area Cutoff Light. (Side View)

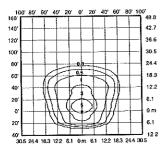

Isotootcandle plot of 400W MH Area Cutoff Light at 30' (9.1 m) mounting height, 0° tilt above horizontal, with backlight shield removed.

		Order Inf	ormation
Housing	Wattage/	Catalog	Mounting Code
Size (sq.) Lamp	Number	(Insert Code at * in Catalog #)
12"	150W PSMH	MAC <u>*</u> 615-M	1 = 1-1/2" Close Pole Mount
16"	150W PSMH	AC <u>*</u> 615-M	2 = 6" Extended Pole Mount
16"	250W PSMH	AC <u>*</u> 625-M	3 = 2" Adjustable Filler
16" (320W PSMH	AC <u>*</u> 632-M	4 = Yoke Mount
16"	400W PSMH	AC <u>*</u> 640-M	6 = 1/2" Adjustable Fitter
22*	750W PSMH	AC <u>*</u> 675-M	(12" housing only)
12"	50W MH	MAC <u>*</u> 405-M	8 = Wilhout Mounting (hardware)
12"	70W MH	MAC*407-M	K = Round Tube Off-Center
12*	100W MH	MAC*410-M	Tenon Mount (16' housing only)
12"	175W MH 4	MAC <u>*</u> 417-M	(For 2-3/8" or 3" O.D.)
16"	175W MH ∢	AC <u>*</u> 417-M	M = Round Tube Off-Center
16"	250W MH ◀	AC <u>*</u> 425-M	Direct Mount (16' housing only)
16"	400W MH ◀	AC <u>*</u> 440-M	(Direct Fitter for 4° sq. pole)
22" (1000W MH	AC <u>*</u> 499-M	W = Wall Mount
12"	35W HPS	MAC <u>*</u> 503-1	(Backlight Shield is standard)
12"	50W HPS	MAC <u>*</u> 505-D	_
12"	70W HPS	MAC <u>*</u> 507-M	NOTE: When using multiple 22" sq.
12"	100W HPS	MAC <u>*</u> 510-M	housings at 90° configuration, a special 12° arm is required; see page 148.
12"	150W HPS	MAC <u>*</u> 515-M	- 2 am o requires see page 1 to
16"	250W HPS	AC <u>*</u> 525-M	_
16"	400W HPS	AC <u>*</u> 540-M	_
4 Cam	o elator arabibi	t these products from he	ing enld

- ◆ Some states prohibit these products from being sold.
- * Specify Mounting (additional cost)

	available-consult factory			
P Reduced envelop	e lamp. ED28 for 320 & 400	W PSMH and 400	W MH; BT37 for 100	OW MH.
Options: (Factory-	installed)	Change	Add After	
Description		Sutfix To	Suftix	
120V Reactor ballast	(50–150W HPS 12" housing only	y) 1		
277V Reactor ballast	(PSMH only)	27		
347V ballast (50W HP	S only)	6		
480V ballast (PSMH,	175-1000W MH & 70-400W HP	Sonly) 5		
480V ballast (70-100)	W MH only)	5		
Tri-volt ballast (PSMI	I, MH & 70-400W HPS only)	T		
Single Fuse (277V Re	actor, 120V, 277V or 347V)	27, 1, 2 or 6	F	
Dual Fuse (208V, 240)	/ or 480V) (n/a Canada)	3, 4 or 5	F	
	/-relay type) (includes 100W Q la			
Button Photocell (Fac	ctory-installed with all mountings	other than 2° Adjusta	ible Fitter)	
NOTE: n/a on 1000	W w/120V; all 480V	27, 1, 2, 3, 4 or	6 P	
External Photocell (F	actory-installed) (Page 131)			
For fixtures w/100	00W, 120V	1	Р	
For fixtures w/480)V	5	Р	
Accessories:				
(Field-Installed)		16"	22"	
Wire Guard	FWG-12	FWG-16	FWG-22	
Backlight Shield	SBL-12	SBL-16	SBL-22	
(standard on AC Series	Wall Mount)			
Button Photocell (Fi	eld-installed in fixtures with 2° Ac	tjustable Fitter)	Catalog #	
For fixtures w/12	OV (n/a on 1000W)		PC-1	
For fixtures w/20	B, 240 or 277V		PC-2	
For fixtures w/34			PC*6	
Mountings				, , Page 114
	Logic/Voltage Suttix Key			
Mounting Alterna	atives ,		Pag	es 148-149
Mounting Bracke	ets		Pag	es 150-151

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Two optical systems are available:


Vertical Lamp, for 50- to 175-watt medium-base lamps. **Horizontal Lamp**, for 175- to 400-walt mogul-base lamps.

Both provide quadrate distribution and great uniformities. The optical chamber is sealed to reduce dirt and insect contamination,

One Size:


16" square x 6.5" deep (406 x 165 mm)

Vertical Lamp Optics

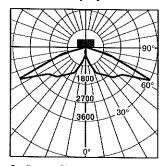


Candlepower Distribution Curve of 16" square 175W MH Vertical Lamp Post Top Light.


Horizontal Lamp Optics

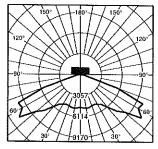

Candlepower Distribution Curve of 16' square 400W MH Horizontal Lamp Post Top Light.

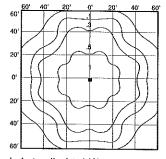

Isofootcandle plot of 16' square 175W MH Vertical Lamp Post Top Light at 20' (6.1 m) mounting height.

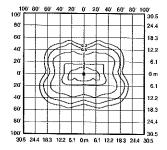

Isofootcandle plot of 16" square 400W MH Horizontal Lamp Post Top Light at 25' (7.6 m) mounting height.

Housing	Wattage/	Catalog	Mounting Code
Size (sq.) Lamp	Number	(Insert Code at <u>*</u> in Catalog #)
Vertical I	Lamp Optics:	:	F = Center Tenon Mount
16"	150W PSMH	QV <u>*</u> 615-M	(Tenon Fitter for 2-3/8" up to 3" 0.D.)
16"	50W MH	QV <u>*</u> 405-M	H = Center Direct Mount
16"	70W MH	QV <u>*</u> 407-M	(Direct Fitter for 4" sq. pole)
16"	100W MH	QV <u>*</u> 410-M	Also available with side pole mount:
16"	175W MH €	QV <u>*</u> 417-M	1 = 1-1/2" Close Pole Mount
16"	50W HPS	QV <u>*</u> 505-D	2 = 6" Extended Pole Mount
16"	70W HPS	QV <u>*</u> 507-M	
16"	100W HPS	QV <u>*</u> 510-M	
Horizonta	al Lamp Opti	cs:	F = Center Tenon Mount
16"	150W PSMH	QH <u>*</u> 615-M	(Tenon Fitter for 2-3/8" up to 3" 0.0.)
16"	250W PSMH	QH <u>*</u> 625-M	H = Center Direct Mount
16" 🌵	320W PSMH	QH <u>*</u> 632-M	(Direct Fitter for 4" sq. pole)
16° 🗘	400W PSMH	QH <u>*</u> 640-M	
16"	175W MH ∢	QH <u>*</u> 417-M	
16"	250W MH ◀	QH <u>*</u> 425-M	
16"	400W MiH ◀	QH <u>*</u> 440-M	
16"	250W HPS	QH <u>*</u> 525-M	······································
16"	400W HPS	QH*540-M	

- ◆ Some states prohibit these products from being sold.
- * Specify Mounting (additional cost)

Other lamp wattages available-consult factory

P Reduced envelope lamp, ED28 for 320 & 400W PSMH.

Options: (Factory-installed)	Change	Add After	
Description	Sutfix To	Sutfix	
277V Reactor ballast (PSMH only)	27		
347V ballast (50W HPS only)	6		
480V ballast (PSMH, 175-400W MH & 70-400W HP	Sonly) 5	,	
480V balfast (70 & 100W MH only)	5		
Tri-volt ballast (PSMH, MH & 70-400W HPS only)	Τ		
Single Fuse (277V Reactor, 120V, 277V or 347V)	27, 1, 2 or 6	F	
Dual Fuse (208V, 240V or 480V) (n/a Canada)	3, 4 or 5	F	
Quartz Standby (delay-relay type) (includes 100W Q i	amp) (n/a 277V Reacto	or) Q	
Button Photocell (n/a on 480V)	27, 1, 2, 3, 4 or	6 P	
External Photocell (480V only) (Page 131)	5	Р	

Accessory: (Field-installed)

Description	III Catalog Number	
Wire Guard	FWG-16	
Mountings	Page 114	
Catalog Number Logic/Voltage Suftix Key	Page 113	
Optical Systems		
Accessories		
Mounting Alternatives		
Mounting Brackets		
Pales		

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January 30, 2015

Mr. Tom Hovel
City Planner
Department of Planning and Development
City of Fitchburg
5520 Lacy Road
Fitchburg WI 53711

Re: City Staff Comments
Lacy Rd. and Syene Rd. -Lot 5

KBA Project # 1332

Dear Mr. Hovel,

We have reviewed city staff comments. Please see our responses in red below and contact Jim Beltran with any questions.

City Staff Comments

- An Administrative Waiver form was completed but was lacking supporting materials. No description was provided specifying what the Waiver is for. Please add the required supplemental information as detailed on the application form. Supplemental information has been added.
- 2.) The plan indicates that the size of the site is 39,061 square feet. The plat shows Lot 5 containing 40,719 sq ft. Please explain this difference. 40,719 SF is correct. Plans and application have been update accordingly.
- 3.) Please better distinguish the property line on plan sheet C-1.1 as it's a bit hard to identify. Line weight has been adjusted.
- 4.) An Administrative Approval is needed for:
 - a. For the additional recess behind the Primary Setback to count toward the Frontage Buildout. See section 5.6.2.f.vii for additional information. You will need to provide a calculation showing that at least 66% of each Façade (street elevation) is built at or up to 18" behind the primary setback. You should also show or indicate that the mechanical louver will be placed on the side recess wall. See item #1's response.

Please complete an Administrative Approval application form for each of these items. The AA form is available at http://www.fitchburgwi.gov/DocumentCenter/View/618. These will be included with the ADR request for the Plan Commission to act on.

5.) An Administrative Waiver is required to use a hedge for streetscreen in non-parking area.
Perhaps this is what the Administrative Waiver form was submitted for in item 1? While this is a



minor item, staff would prefer that only street screen wall be used along Aurora rather than using an Evergreen Hedge as we believe it looks nicer and provides a better feel. A streetscreen wall and hedge combination was used on No Oaks Ridge in Uptown and staff thinks that it might have a better look if it used a streetscreen wall throughout. The hedge along Aurora has been removed, but we feel the hedge is still the best option for the space between the building and detention basin so it has been included with this resubmittal.

- 6.) What is the material of the balcony railings? Powder coated aluminum.
- 7.) Signage shall comply with Chapter 23 SmartCode. Signage will be determined at a later date.
- 8.) The application states that the lot width is 180 feet. Please confirm if this is correct. Lot width on the primary frontage side is 214'-0". Application has been updated accordingly.
- 9.) Parking: Plan sheet C-1.1 notes that there are 60 underground stalls but the engineering drawings and landscaping plan note 59. Please be consistent. This has been corrected.

You should also be aware that only ½ of the available parking along the parking land corresponding to the lot Frontage for residential use counts toward the parking. Given this, you can count 4 street parking stalls to your parking totals. Parking counts have been revised.

- 10.) What is the pitch of the roof? 4.25/12
- 11.) Please confirm that all exterior lighting fixtures are dark sky or full cutoff as not all the cut sheets specified. Yes. Light fixtures are dark sky compliant. The requirement for necessary cutoffs has been noted on the site lighting plan.
- 12.) Due to the increased building articulation and use of vinyl siding, this plan requires approval from the City's Plan Commission. This request is scheduled to be on the Commission's February 17, 2015 Plan Commission agenda.
- 13.) Park Improvement Fee: The developer paid \$47,600 (check # 000004) in park improvement fees for 340 dwelling units. This amount was based on five, 68-unit buildings in the North Park Plat.

Lot 4 – 68 units Lot 3 – 71 units Lot 5 71 units

With development of Lots 3, 4 & 5, there is a remaining balance of park improvement fee for 130 units. Please note that if the future development on Lots 1 & 2 exceeds 130 units, additional park improvement fee will need to be collected.

Sincerely,

J. Randy Bruce Managing Member

February 3, 2015

Mr. Cory Horton
Director of Public Works
Department of Public Works
City of Fitchburg
5520 Lacy Road
Fitchburg WI 53711

Re: Public Works Review Comments Lacy Rd. and Syene Rd. – Lot 3

KBA Project # 1332

Dear Mr. Horton,

We have reviewed the Public Works comments. Please see our responses in red below and contact Jim Beltran with any questions.

Public Works Review Comments

General Comments

- 1. Please confirm that refuse and recycling container(s) are located and sized properly. Trash enclosure is located within the basement. Size is adequate.
- 2. The applicant will need to submit a Construction & Demolition Reuse/Recycling Plan to Public Works. This will be completed prior to construction.
- 3. Please note on the plans that a street opening permit is required for all work within the right-of-way and that all work performed in the right-of-way needs to be completed in accordance with the latest edition of the City of Fitchburg's Standard Specifications or Public Works Construction. Requirement has been added to C-1.1.
- 4. A street tree waiver will need to be signed by the Owner for street trees to be planted by the City along Aurora Avenue. Understood.

Transportation Comments

- Driveways should follow the Commercial Driveway Standards of the City of Fitchburg, consisting of a
 concrete apron and straight tapers to meet the public street. This drawing can be found in the City's
 Standard Specifications document, available on our website:
 http://www.city.fitchburg.wi.us/departments/cityHall/publicWorks/documents/StandardSpecifications.p
 df Requirement has been added to C-1.1.
- 2. The bike parking areas that are located adjacent to public sidewalk shall provide a minimum 2-ft clear zone between the edge of the sidewalk and a parked bicycle. To maintain this clearance, bike racks that are perpendicular to the sidewalk should be mounted no closer than 4' to the edge of the sidewalk. See detail 6 / C-1.1.
- 3. The bike parking areas that are located adjacent to the bike path shall provide a minimum 3-ft clear zone between the edge of the path and a parked bicycle. To maintain this clearance, bike racks that



- are perpendicular to the path should be mounted no closer than 5' to the edge of the path. See detail 6 / C-1.1.
- 4. Sidewalk adjacent to Lot 3 shall be installed per the First Amendment to the Agreement for Subdivision Improvements in the Plat of North Park (Documents #5116733). Will comply.
- Label expansion joint between private stairs and public sidewalk. Requirement has been added to C-1.1
- 6. The City is still deciding on a pedestrian-scale street light which will be located in the terrace area between the sidewalk and the curb and gutter. It is likely that at least one new street light, possibly 2, will be required along Aurora Ave. within the limits of the street frontage for Building 3. Understood.
- 7. The bike path along Lacy Road shall remain open during construction and shall not be used by the building contractor. Any damages to the path, caused by the building construction, shall be repaired prior to occupancy. Understood. This has been noted on C-1.1.

Water Main and Sanitary Sewer


- 1. Water impact fees will need to be paid prior to release of any building permits. These fees will be included with the permit fee. The 2015 impact fee rate is \$729/Unit. Understood.
- If Syene Interceptor fees have not been paid for the North Park development. Per the Agreement for Subdivision improvements, once these fees are invoiced they will need to be paid within 30 days. Understood.


Erosion Control and Stormwater Management (ECSWM) Comments

- A new Erosion Control & Storm Water Management permit application will need to be submitted to the Fitchburg Public Works Department for review and approval (The ECSWM application and information on requirements can be found at: http://www.fitchburgwi.gov/231/ECSWM-Requirements.
 Will comply.
- 2. A stormwater maintenance agreement (recorded at the Dane County Register of Deeds office) will be required for the necessary private stormwater management practices approved by the City (e.g. private storm sewer, rain gardens, etc.). The owner(s) would be eligible for up to a 50% reduction in stormwater utility rates for the proposed stormwater practices. The following link: http://www.fitchburgwi.gov/230/Credit-Opportunities provides the application form and details on this program. Will comply.
- 3. This site is within the McGaw Park Neighborhood which has stormwater performance standards (e.g. 100% stay-on infiltration volume, etc.) described in the approved plan at: http://wi-fitchburg.civicplus.com/385/McGaw-Park-Neighborhood-Plan. The designer may contact Fitchburg's Environmental Engineer at 270-4264 or rick.eilertson@fitchburgwi.gov if he/she has any questions on ECSWM performance standards for this site. Will comply.

Sincerely,

J. Randy Bruce Managing Member

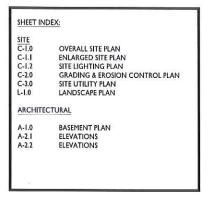

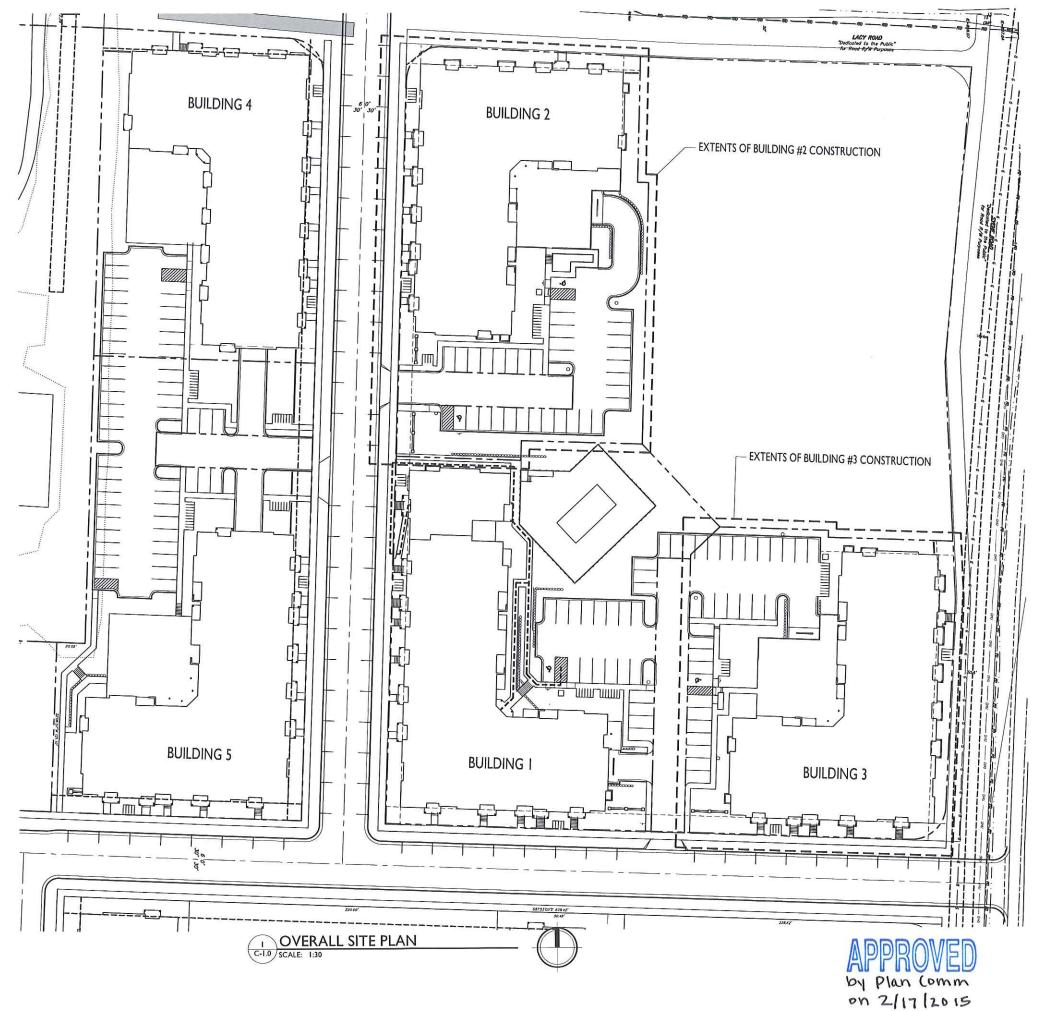



ISSUED
Article 5 Submittal: January 15, 2015
Article 5 Re-Submittal: February 5, 2015


PROJECT TITLE
THE ADDISON
BUILDING 3


AURORA AVENUE & SYENE ROAD
SHEET TITLE
SITE PLAN

SHEET NUMBER

C-1.0


PROJECT NO. 1332

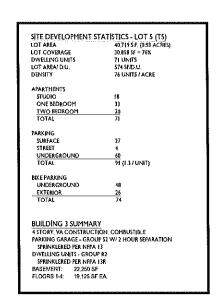


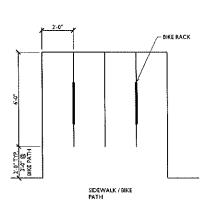



BIKE PARKING DETAIL

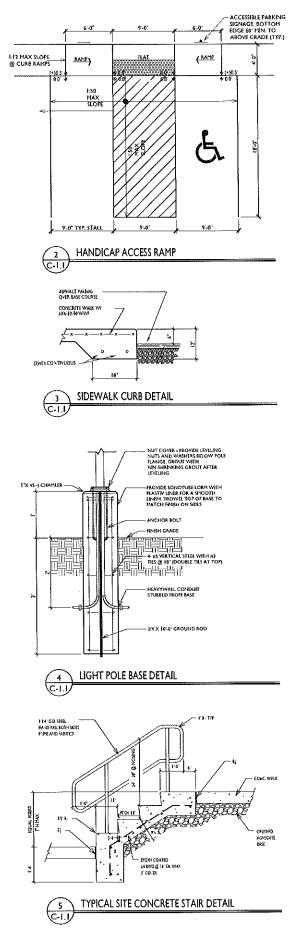

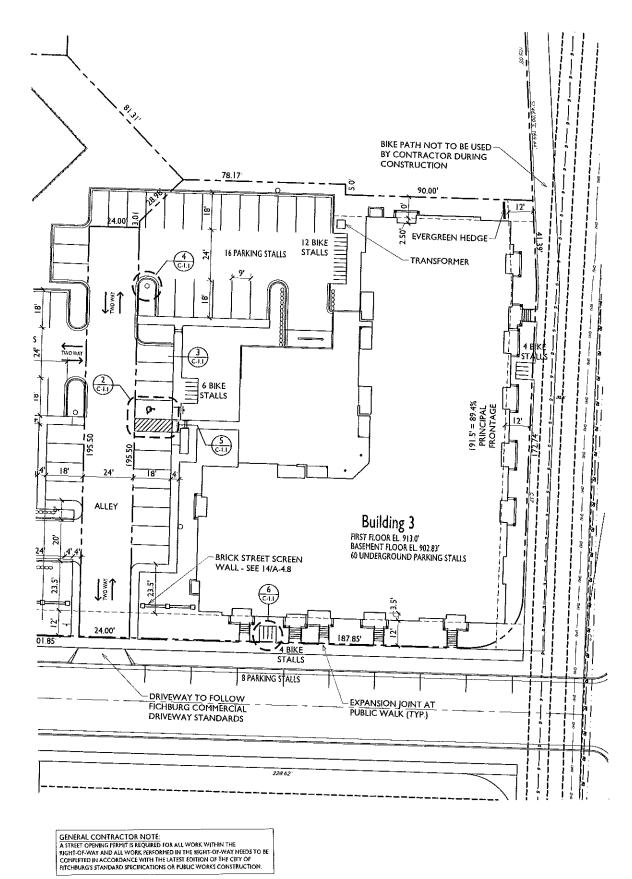

BUILDING #3 SITE PLAN

C-1.1 SCALE: 1:20



ISSUED Article 5 Submittal: January 15, 2015 Article 5 Re-Submittal: February 5, 2015

PROJECT TITLE THE ADDISON **BUILDING 3**

AURORA AVENUE & SYENE ROAD SHEET TITLE SITE PLAN

SHEET NUMBER


⊗ Knothe & Bruce Architects, LLC

1332

mbol	Label	Oty	Manufacturer	Calalog Number	Description	Lamp	File:	Mounting
	Α	2	RUUD LIGHTING	E8405	RECTANGULAR SECURITY / DEEP SHIELDED	SOWATT MH	E85073ES	6'-0" AOVE GRADE ON SIDE OF BUILDING
ø	В	3	RUUD LIGHTHIG	MAC410SBL	12" AREA CUTOFF / V/BACK LT. SHIELD	HITTAN 001	MAC417SBL.je	16-0" POLE ON 2'-0" TALL CONC. BASE
ø	С	3	RUUD LIGHTING	QV410	16' QUADRATE VERTICAL / TYPE V	HAS TT AVV DOS	QV417.Jes	16-0" POLE ON 2-0" TALL CONC. BASE
ø	D	4	RUUD LIGHTING	AC640-MSBL	15" AREA CUTOFF / WIBACK LT, SHEELD	400 WATT PSAM	AC525SBLJes	22'-0' POLE ON 2'-0' TALL CONG. BASE

LIGHTING S	TATISTICS	*****				
Description	Symbol	Avg	Max	Min	Maratin	АудМіл
Parking	+	1.2 ts	6.3 le	0.3 lc	27.7:1	4.0:1

17.6 fc

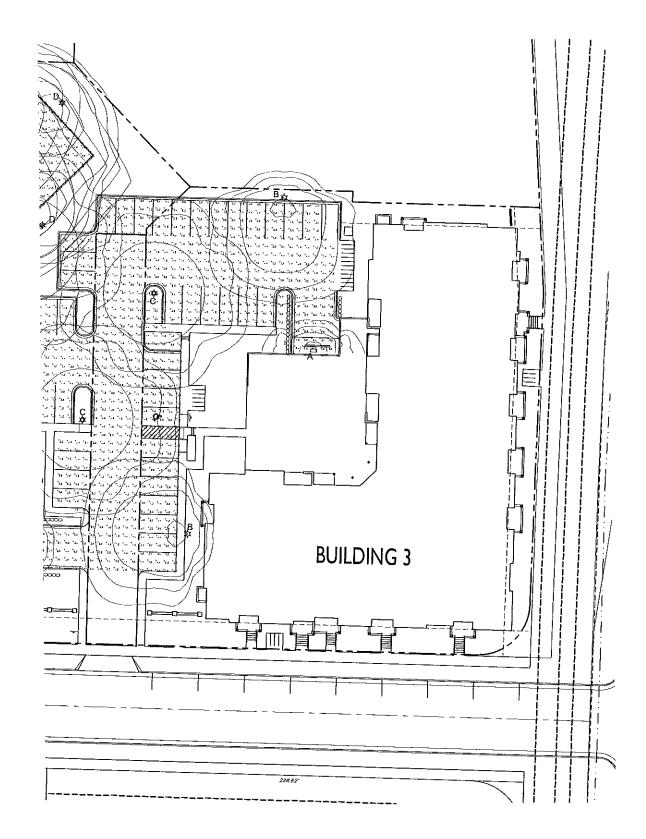



|SSUED Article 5 Submittal: January 15, 2015 Article 5 Re-Submittal: February 5, 2015

PROJECT TITLE
THE ADDISON
BUILDING 3

AURORA AVENUE &
SYENE ROAD
SHEET TITLE
SITE LIGHTING
PLAN


SHEET NUMBER


C-1.2

PROJECT NO. 1332

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CONTRACTOR SHALL BE RESPONSIBLE FOR ADJUSTING ALL UTILITY STRUCTURES (MANHOLE RIMS, WATER VALVES, AND

5. IF DEWATERING OPERATIONS EXCEED 70 GALLONS PER MINUTE OF PUMPING CAPACITY, A DEWATERING WELL PERMIT SHALL BE OBTAINED FROM THE WESCONSIN DIR PRIOR TO STARTING ANY DEWATERING ACTIVITIES.

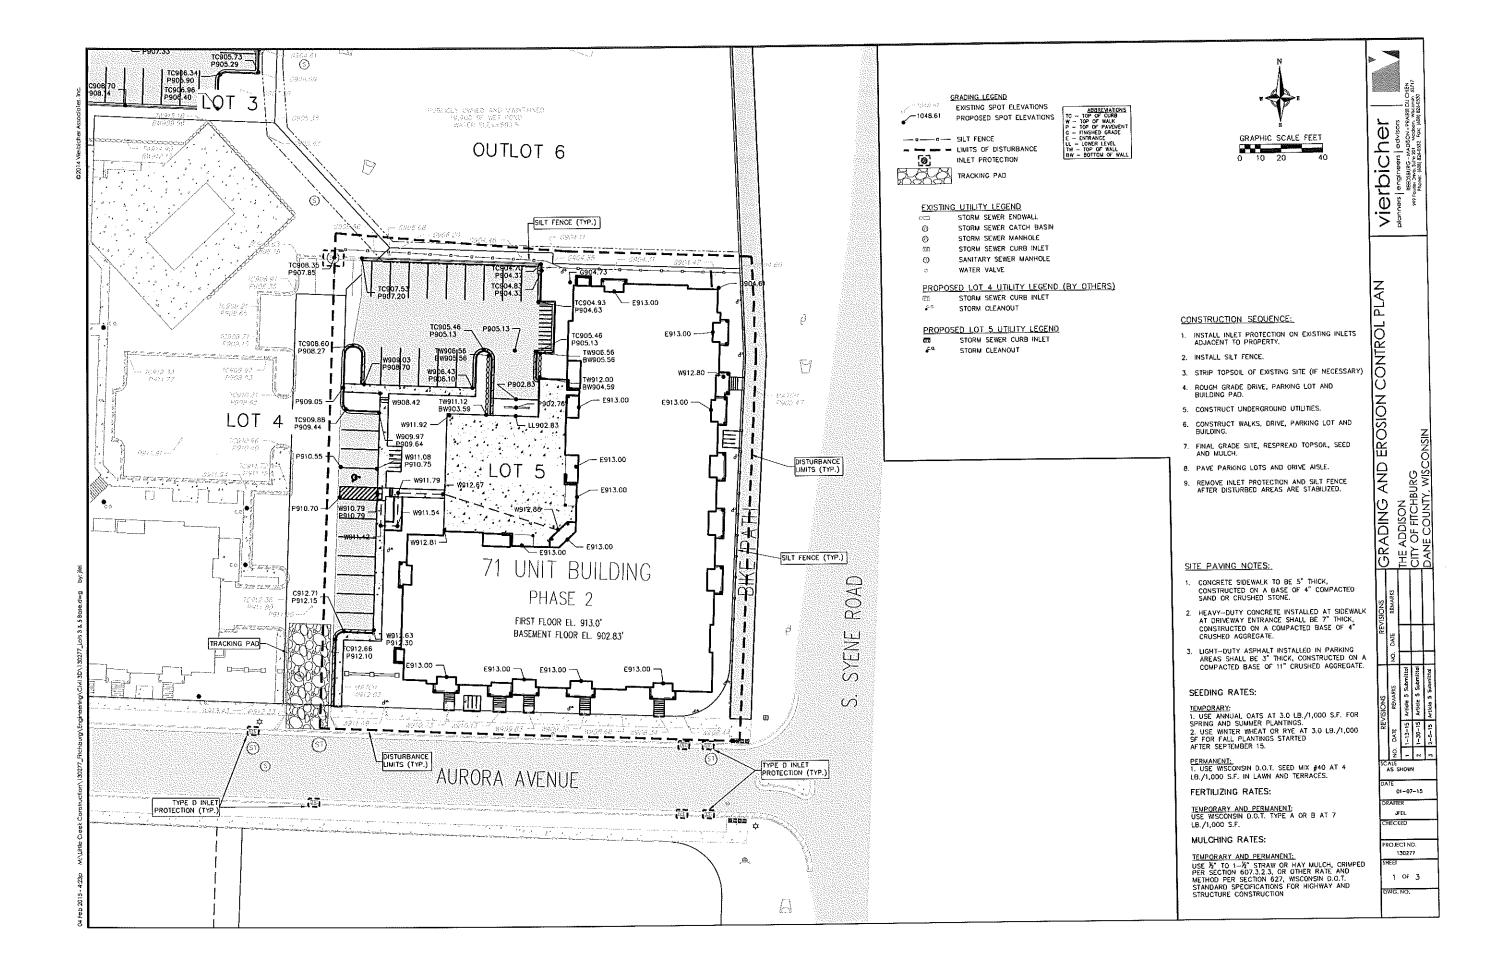10. A MEANS TO LOCATE BURIED UNDERGROUND EXTERIOR NON METALLIC SEWERS/MAINS AND WATER SERVICES/MAINS MUST BE PROVIDED WITH TRACER WIRE OR OTHER METHODS IN ORDER TO BE LOCATED PER SPS 382.10(11)(h) AND SPS

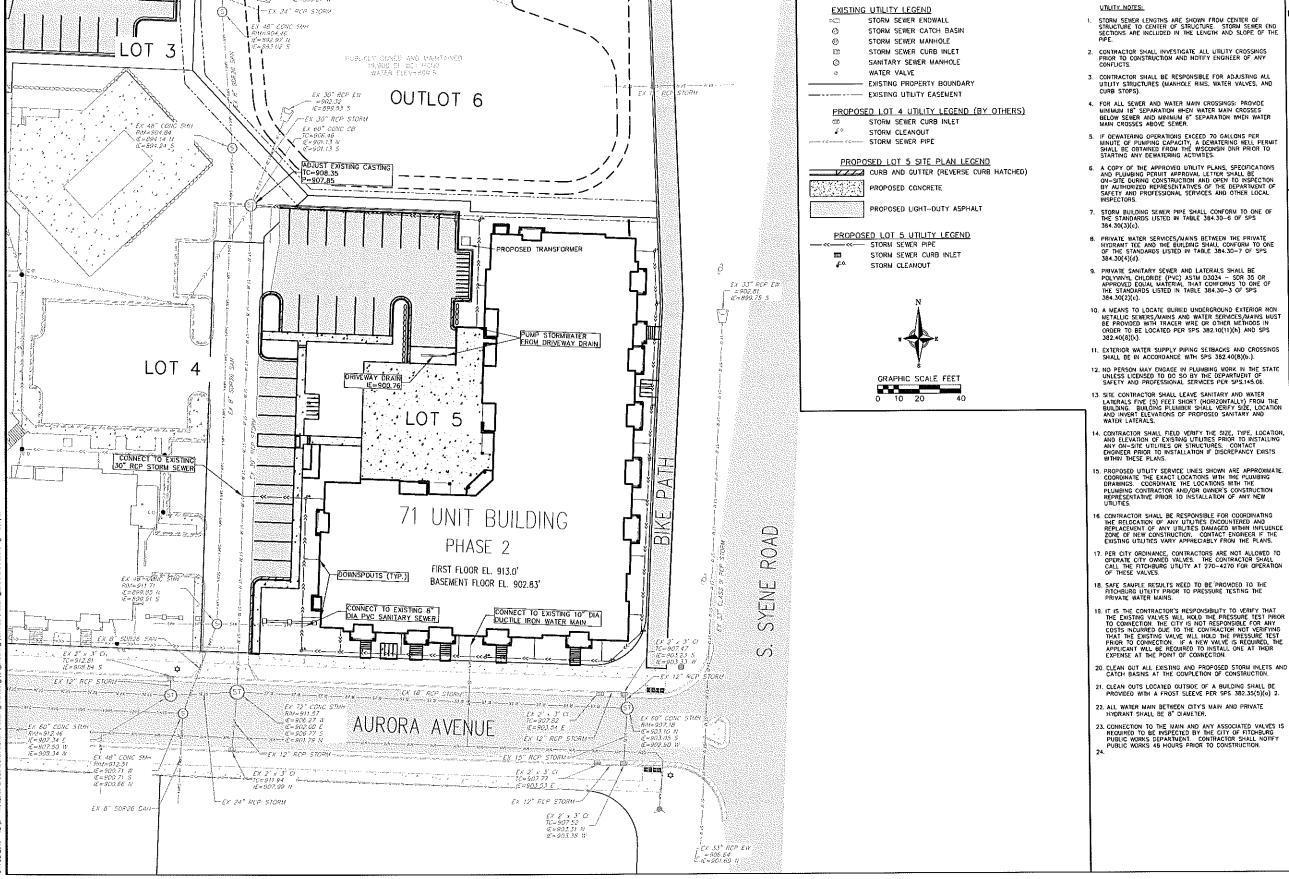her erbic Inners | engineers |

> Ą NO - 2 K AS SHOWN

> > 01-07-15

JFEL HECKED

PROJECT NO.

130277


2 OF 3


WG. NO.

MOUNTABLE BERM 6" MIN, HEIGHT

- 1. FOLLOW MISCONSIN DNR TECHNICAL STANDARD 1057 FOR FURTHER DETAILS AND INSTALLATION.
- 2. LENGTH MINIMUM OF 50°.
- 3. WIDTH 24" MINIMUM, SHOULD BE FLARED AT THE EXISTING ROAD TO PROVIDE A TURNING RADIUS.
- 4. ON SITES WITH A HIGH GROUND WATER TABLE OR WHERE SATURATED CONDITIONS EXIST, GEOTEXTILE FABRIC SHALL BE PLACED OVER EXISTING GROUND PRIOR TO PLACING STONE, FABRIC SHALL BE WISDOT TYPE—HR GEOTEXTILE FABRIC.
- 5. STONE CRUSHED 3" CLEAR STONE SHALL BE PLACED AT LEAST 12" DEEP OVER THE ENTIRE LENGTH AND WIDTH OF ENTRANCE.
- 6. SURFACE WATER ALL SURFACE WATER FLOWING TO OR DIVERTED TOWARDS CONSTRUCTION ENTRANCES SHALL BE PIPED THROUGH THE ENTRANCE. MAINTAINING POSITIVE DRAINAGE. PIPE INSTALLED THROUGH THE STABILIZED CONSTRUCTION ENTRANCE SHALL BE PROTECTED WITH A MOUNTABLE BERN WITH 5:1 SLOPES AND MINIMIMUM OF 6° STONE OVER THE PIPE PIPE SHALL BE SIZED ACCORDING TO THE DRAINAGE REQUIREMENTS. WHEN THE ENTRANCE IS LOCATED AT A HIGH SPOT AND HAS NO DRAINAGE TO CONVEY A PIPE SHALL NOT BE NECESSARY. THE MINIMUM PIPE DIAMETER SHALL BE 6°. CONTRACTOR SHALL BE RESPONSIBLE FOR THE MAINTENANCE OF SAID PIPE.
- 7. LOCATION A STABILIZED CONSTRUCTION ENTRANCE SHALL BE LOCATED WHERE CONSTRUCTION TRAFFIC ENTERS AND/OR LEAVES THE CONSTRUCTION SITE. VEHICLES LEAVING THE SITE MUST TRAVEL OVER THE ENTIRE LENGTH OF THE TRACKING PAD.



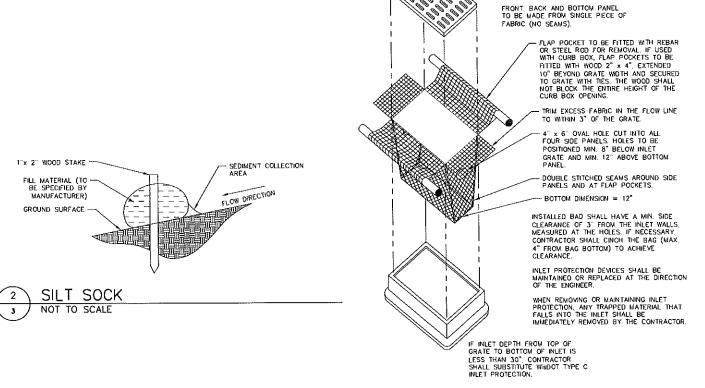

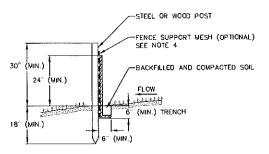

INSTALL SILT FENCE TO FOLLOW THE GROUND CONTOURS AS CLOSELY AS POSSIBLE.

NOT TO SCALE

- CURVE THE SILT FENCE UP THE SLOPE TO PREVENT WATER FROM RUNNING AROUND THE
- 3. POST SPACING WITH FENCE SUPPORT MESH =
- POST SPACING WITHOUT FENCE SUPPORT MESH = 6 FT. (MAX.)
- 4. SILT FENCE SUPPORT MESH CONSISTS OF 14-CAUGE STEEL WIRE WITH A MESH SPACING OF 6 IN X 6 IN. OR PREFABRICATED POLYMERIC MESH OF EQUIVALENT STRENGTH



BAG TO BE CONSTRUCTED USING GEOTEXTILE FABRIC, WISDOT TYPE

DIMENSIONS OF TOP OPENING OF BAG TO MATCH INLET GRATE.

INLET PROTECTION TYPE D

ierbicher . Plann

CONSTRUCTION DETAILS
NORTH PARK - PHASE 1 - LOT 4
CITY OF FITCHBURG
DANE COUNTY, WISCONSIN

CALE AS SHOWN

06-05-14 JF€L IEC.KED

> PO JECT NO 130277

> > 3 OF 3

Key		Botorical Name	Common Name	Site/Condition
Trees				
Amil		Acer miyabei Morton	STATE STREET MYABE MAPLE	2 /2-3/b b
	3	Corpinus betulus Frone Fontaine	FRANS FONTAINE BUROPEAN HORNBEAM	2 //2-3 ⁷ /b, b
Pgv	Ц.	Piceo glauco var. densato	BLACK HILLS SPRUCE	7-8//a.h.
Pm	μ,	Prurus maadkii	ATUR CHOKE CHERRY	D-D/aa
PcC	4	Pyrus calleryano 'Cleveland Select'	CLEVELAND SELECT CALLERY PEAR	2 1/2-31/0 t
O-F	3	Overous rotor Fostigiald	FASTIGATA ENGLISH OAK	2 V2-37a.b
51	5	Syringo reticulata Ivary 5%	MORY SLK JAPANESE TREE LLAC	b-b/a a
TIS :	2	Têo tomentoso Sterfro	STEPLING SLIVER UNDEN	2 V2-3 / L t
Strub:				
Arts		Aronia melanocarpo Mortani	ROQUOS BEAUTY SLACK BERRED ARONA	13-24 /cont.
BGV :		Bunus Green Velvet	GREEN VELVET BOXWOOD	13-24 /b, b.
CoB	ji j	Comus alba "Balhald"	MORY HALO DOGHOOD	24-36/cont
DI :	3	Diervilla foricera	BUSH HONEYSUCKLE	B-24/cont.
DsC :	5	Dienvillo sessistratio Coal Splanti	COOL SPLASH BUSH HONEYSUCKLE	13-24/cont.
ExC :	3	Exonymus alatus Compactus'	DHARF BURNING BUSH	24-36/cont
HoA	2	Hydrangea orborescens 'Annabelle'	ANNABELLE HYDRANGEA	13-24/cont.
Han	2	Hydrangea orbonescens NCHW PP: 20765	invincibe@et(, Spirit Hydrongea	13-24 /cont.
	14	Hydrongeo poniculato "Jone"	UTTLE LIME HYDRANGEA	10-24/conu
J/G	5	Juniperus virginiano Grey Qué	GREY OWL BURK EASTERN RED CEDAR	B-24 /cont.
PaD	4	Physicianius apulifalis Donna May	LITTLE DEVIL NINEBARK	24-367/cont
Prrft		Piceo mariano Nara	BLUE NEST SPRICE	13-24/cont.
RøG	b	Rhus aramatka Gno-faui	GRO-LOW FRAGRANT SUMAC	13-24/cont.
Rrf	۱	Rosa rugosa Frau Dagmar Hastrup	FRAU DAGMAR HASTRUP JAPANESE ROSE	B/cont.
5 61	6	Spiraeo betalifolio 'Tor'	TOR SPIREA	10-24/cont,
5 ja	3	Spiraeo japanica 'Anthony Haterer'	ANTHONY WATERER SPIREA	B-24/cont.
TmH		Tous x medio Nicksii	HCKS YEM	13-24 /2.5
ŢdL	6	Thu ja occidentalis Vittle Giant'	LITTLE GANT ARBORVITAE	8-24/con.
		Grottes		
CoK	3	Colomograstis x acutiflora Karl Foerster	KARL FOERSTER FEATHER REED GRASS	# cont.
P/P	4	Parkum virgotum Prairie Sky	FRARE SKY SWITCH GRASS	ri cont.
f¥5	6	Pariam virgotum ShenardooH	SHENANDOAH RED SWITCH GRASS	# cont.
		nd Arnule		
Am	6	Alchemita motis	LADYS MANTLE	H cont.
GR.	13	Geronium Rozonne	ROZANNE CRANESBLL	# cont.
HP8	6	Hemerocalis Prairie Blue Eyes'	PRARIE BLUE EYES DAYLLY	H cont.
H6d	18	Hamerocollis Stello diOrd	STELLA DORO DAYLLY	pd cont.
lg	6	his germanica	TALL BEARDED R6	ri cont.
MМ	7	Hepelo x foothers highers Loui	WALKERS LOW CATMINT	of cont.
PaH	45	Perstamon datain Histor Red	HJEKER RED POYSTEMON	rd cont.
PaL	6	Perovskia atriplicitalia Little Spire	UTTLE SPRE RUSSIAN SAGE	# cont.
RIG	30	Rudbeddo fulgido Goldsturmi	GOLDSTURM BLACK-EYED SUSAN	IA cont.
SAJ	40	Sedum 'Autumn Joy'	AUTUMN JOY SEDUM	# cont.

PLANTING NOTES:

PLANTING NOTES:

1. CONTRACTOR SHALL VEREY LOCATION OF ALL ON-SHE UILINES PROR TO COMMENCE ANY WORK OFF-SHE.

WISTAID STALLUTE 182.0175 REQUES THRE WORK DAYS NOTCE BEFORE YOU EXCAVATE. CALL

DOCER'S HOTENE AT 1-800-242-8511

25 FPLY AD NOTAL ALL WISCONS GROWN INFSERY STOCK, GUARANIEE ALL STOCK FOR A PERCO OF OR YEAR AD INSTALL ALL WISCONS GROWN INFSERY STOCK, GUARANIEE ALL STOCK FOR A PERCO OF OR YEAR AD INFORMATION OF A PERCO ON THE PROPOSED PLANS. IF ANY DISCREPANCES ARE PRESENT BETWEEN PLANT LEGEND AND GRAPH CEPPCTUR, GRAPHCALLY EXPLCED CONTINUES SHALL HOLD PRECEDENCE.

3)ACTUAL LOCATIONS OF PLANT MATERIAL ARE SUBJECT TO FINAL SHE LAYOUT AND CONTINUES AND MAY BE ADJUSTED ACCORDING.

SHARTINL LOCATIONS OF PLANT MATERIAL ARE SUBJECT TO FINAL SITE LAYOUT AND CONTIONS AND MAY BE AGUISTED ACCORDINGLY.

AGUIS MOD STARE ALL LARGE TREES AND DYTROPENS.

SHALL PLANTS ARE TO BE BACIFIED WITH A 50/150 MX OF PLANT STARTER AND TOPSOL BLIND AND IS TO BE FREED OF ROUTS, ROCKS LARGER THAN 1" IN STARLETER, SUBSOL (BERIS), NOW WELDS.

GOODS AND RENDYE THE TOP BURLAF AND TIME OR STRING FROM ALL BALLED AND BURLAFFED PLANTS AND SET ALL PLANTS AT PROPIED GRADE.

TO SUPPLY AND YESTELL 3-4" OF STREEDED ARREWINDO BARK MILCH IN ALL PLANTING BLOGS, AND 1-11/2" IN ALL PERFENTAL BEGS. THEAT ALL AREAS WITH A PRE-DERIGHTH PERFORM GRADULAR FORM "TERTLAN" OR APPROVED BURLAF FOLLOWING ALL MARKAS WITH A PRE-DERIGHTH PERFORM BEGS. THE ALL AREAS WITH A PRE-DERIGHTH PERFORM GRADULAR FORM "TERTLAN" OR APPROVED BURLAF FOLLOWING ALL MARKAS WITHEN INSTALLAR IN PRINCIPLES FROM TO PLACING MICH.


MAICH
BOUPPLY AND INSTALL 3-4" OF SHEEDEED HARDWOOD MUCH I' PAST THE CRP LINE OF ALL INDIVIDUAL
TREES. DO NOT PLACE MILCH ACARDST TRIEN, OF TREE.
SOUTHLY AND INSTALL BLACK VIVIL EICAND "ARE OF DANAID" MANFACTURED BY VALLEYVEW NOUSTRES

OR APPROVED EQUAL IN ALL PLANTERS BEDS THAT ADJON TURE AREAS ACCORDING TO THE MANUFACTURER'S

OR APPROVED EQUAL IN ALL PLANTING BEDS THAT ADJOIN THE AREAS ACCORDING TO THE MANAGACHERE'S WARTEN BESTALLATION BETRICIONS.

10 IAUL TURE AREAS ARE TO BE FIRE-GRADED. ALL TURE AREAS ARE TO BE SELECT, AREAS ARE TO BE SOWN AT THE MANAGACHERE'S RECOMMENDED RATES AND COVERED WITH A CLEAN GAT STRAW. THE READ AS ARE TO BE SOWN WITH PALSON LADSCARE'S COLORIO BLEDGED SELECT RELAYMENS MUTS TO BE APPLIED AT THE RECOMMENDED RATE, A STANTAR FERTILIZER APPLIED, AND COVERED WITH A CLEAN GAT STRAW, ANY AREAS WHERE POTENTIAL RESISTANT WITH STRAW MORSES CONTROL RAVACES TO DO 750. TO MANAGEMENT AND ALL SLOTES OF \$1 OR GREATER SHALL BE CONTROL WITH STRAW MORSES CONTROL RAVACES TO 105-750 MANAGEMENT AND ALL SLOTES OF MICH.



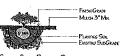










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B 262-549-9229

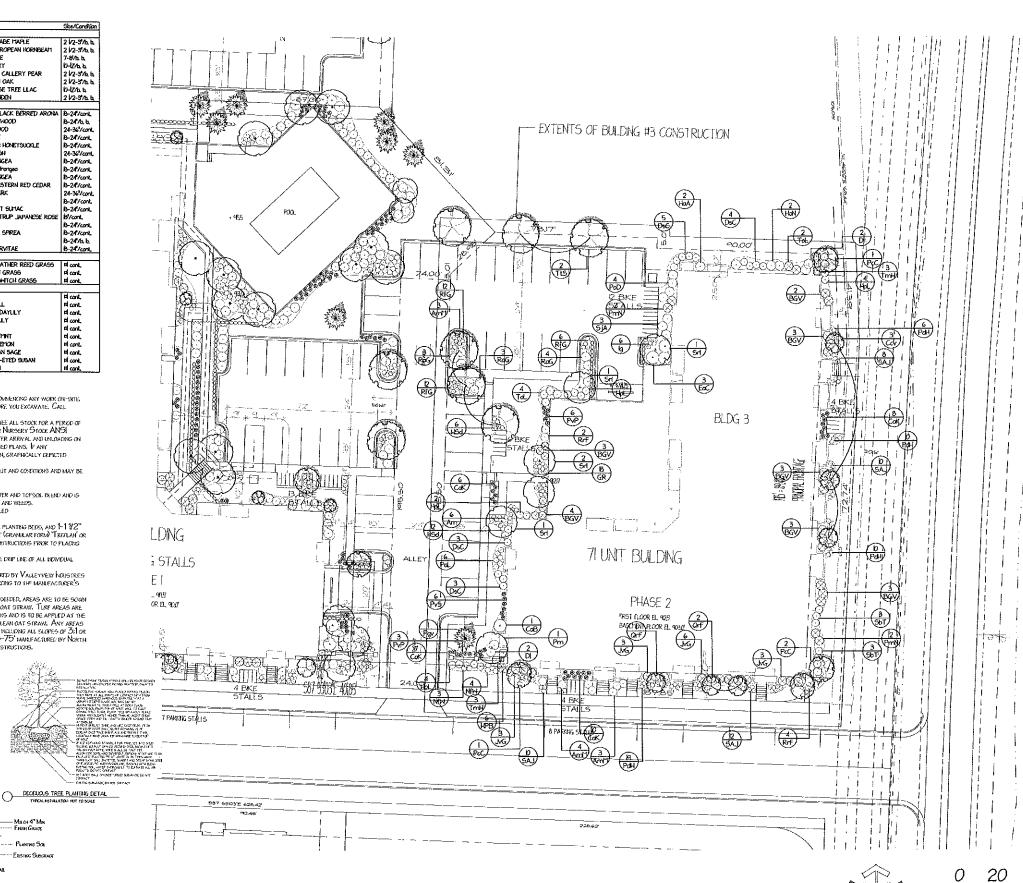www.nelsonlandscape.com

Sheet Title:

LANDSCAPE PLAN

Project.

ARTICLE 5 SUBMITTAL:

THE ADDISON FITCHBURG, WI

Plan Notes:


Designed By: C. J. N. Drawn By: C. J. N. Date: 1-13-15 Revisions: 1-30-16, 2-05-15

Notice.

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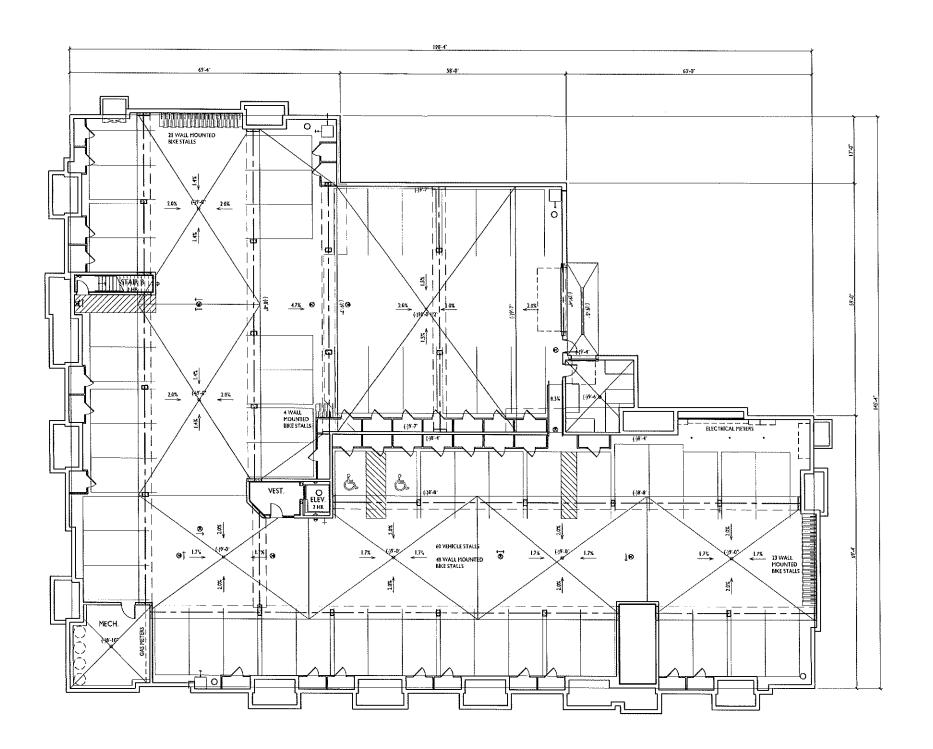
This plan is subject to final on-site conditions and may be modified to account for unforseen obstacles, other changes, or site modifications that were not made known at the time of preparation dated on this plan.





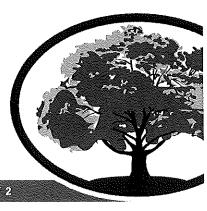

40





ISSUED Article 5 Submittal: January 15, 2015

PROJECT TITLE
FEDLER SYENE RD
PHASE 2
BUILDING 3

AURORA AVENUE & SYENE ROAD
SHEET TITLE
Basement Floor
Plan

SHEET NUMBER

A-1.0

PROJECT NO. 1332
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ISSUED

Article 5 Submittal: January 15, 2015 Article 5 Re-Submittal: February 5, 2015

PROJECT TITLE THE ADDISON **BUILDING 3**

AURORA AVENUE & SYENE ROAD SHEET TITLE **EXTERIOR ELEVATIONS**

SHEET NUMBER

PROJECT NO. @ Knoxhe & Bruce Architects, LLC

EXTER	IOR MATERIAL	SCHEDULE
BUILDING MATERIAL	MATERIAL	COLOR
ROOF	ASPHALT SHINGLES	OWENS CORNING PRO 30; DRIFTWOOD
ROOF FLASHING	ALIMINUM	TBD - YERIFY W/ ARCHITECT
HORIZONTAL VINYL SIDING - (I)	VINYL	CERTAINTEED MONOGRAM 4& SUEDE
HORIZONTAL VINYL SIDING - (2)	YINYL	CERTAINTEED MONOGRAM 46: SABLE BROWN
COMPOSITE TRIM AND PANELS	COMPOSITE	SW 7531 "CANVAS" TAN"
ALUMENUM FASCIA	MUMMULA	HASTIC "ALMOND"
BRICK YENEER	HASONRY	SORAL - ALLENOALE HILL KENG SIZE
HORTAR COLOR @ BRICK VENEER	HASONRY	QUEKRETE "WHEAT"
SEALANT @ BRICK VENEER	T.B.D.	TBO (MATCH BAICK) - SUBMIT TO ARCHITECT
METAL FLASHING @ BRICK VENEER	GALY, STEEL	PAC CLAD "MANSARD BROWN"
CAST STONE SILLS & HEADS	CAST STONE	EDWARDS CAST STONE, 18-018
HETAL FLASHING @ PRECAST	GALY, STEEL	PAC CEAD "ALHONO"
WINOOWS	VINYL	TAN
SEALANT @ WINDOWS	TAD,	TO HATCH WINDOWS
RAILING	ALUMINUM	DARK BRONZE
DECK BOARDS	TREATEO WOOD	ТВО
DECK SKIRT	COMPOSITE	SW 7531 "CANVAS TAN"
FLASHING @ DECK EDGE	GALY, STEEL	PAC CLAD "ALMONO"
FLASHING @ DECK LEDGER	GALV. STEEL	HATCH ADJACENT SIDING/MASONRY
ENTRY DOORS	INSULATED HETAL	DARK BRONZE
GARAGE MAN DOOR	INSULATED HETAL	SW 3531 "CANYAS TAN"
OVERHEAD GARAGE DOOR	ALUMINUH	CHT VIWONO
SWINGING UNIT PATIO DOORS	FIBERGLASS	STARVED - TED BY ARCHITECT





ISSUED Article 5 Submittal: January 15, 2015 Article 5 Re-Submittal: February 5, 2015

PROJECT TITLE THE ADDISON

BUILDING 3

AURORA AVENUE & SYENE ROAD SHEET TITLE **EXTERIOR ELEVATIONS**

SHEET NUMBER

BUILDING MATERIAL BREAKDOWN IS

COMBINED WITH WEST ELEVATION

HIDDEN ELEVATION

A-2.2 SCALE 1/8"=1'-0"

A-2.2

PROJECT NO. 1332 O Knothe & Bruce Architects, LLC



BUILDING MATERIAL	1 %
DOOMS / WINDOWS	27 X
VINYL SIDING	25 X
COMPOSITE TRIM & PANEL	9%
BRICK VENEER / CAST STONE	39 %

BUILDING MATERIAL % DOORS / WINDOWS 27 % VINYL SIDING 25 % COMPOSITE TRIM & PANEL 11% BRICK VENEER / CAST STONE 37 %

WEST ELEVATION 2 WES I ELE A-22 SCALE 1/8"=1'-0"